TOWN OF MARBLEHEAD SITE PLAN APPROVAL APPLICATION PLANNING BOARD

1.	Property Address: 14 EDC+Z+15CP+E PD.
2.	Assessor Map 178 Lot 13 3. Zoning District 64/558
4.	Applicant: PPLICTO & JOSHATE SUMPLIDA
5.	Applicant's Address 14 Textentiers R12.
6.	Telephone Number: 978.500. (Daytime)(Evening)
7.	Email address: Joannetalmerda e gmand.com
7.	Applicant's Representative terevices Hopson Taprest DESIGN
8.	List other permits required and status (e.g. Old & Historic Districts, Conservation, Board of Appeals, etc., obtained, scheduled, etc.)
	Consternation: MINOR ACTIVITIES PERMIT
	ZBA
	2.14.24
	(Signature of Owner) Representative (Date)
	ne and mailing address and phone number that the legal advertisement should be billed to
Addre	SS 450 OCTAN DR JNIT BOX
عاماء	50 PSTEACH, FL. 33408
	978.500.1328
	FOR TOWN USE ONLY
Applic	eation Received Submittal Deemed Complete
Waive	rs
	aled Hearing Date File Number

PLANNING BOARD

Applicant:

Bruce & Joanne Almeida

Address:

14 Edgemere Road (Map 178, Parcel 13)

District:

Single Residence/Shoreline Single Residence

Proposal:

The proposal before the board is to remove an existing single-family home that has been in the same family since its construction in 1923. The cottage includes a small two-story structure on a full foundation, three long, narrow, single-story enclosed porches, and no garage.

The proposed new home, with gambrel roof, wrapping porch and attached garage, will provide single-floor living that would allow an age-in-place situation for the same family to continue on in that location.


The overall aesthetic of the home will be a gambrel-roofed, shingle-style home, appropriate for its coastal location and in keeping with the original cottage. The homes in the immediate neighborhood vary from traditional 2-story colonial, Dutch-colonial, and more modern shingle-style homes.


The proposed structure is located on an expanded version of the original footprint, while remaining consistent with the scale of surrounding homes, and maintains the front and rear setbacks (those perpendicular to the shoreline) in order to preserve air flow and water views between this and abutting homes. The finish height will be slightly less that the original structure.

Exterior materials include cedar shingle siding, architectural-grade asphalt roofing shingles, divided-lite windows and doors, carriage-house style garage doors, fieldstone-clad chimney, and trim details that mimic the traditional style with added crown and bed mouldings. The porch will have composite decking in a natural wood tone, traditional railing system, and beadboard or 'v'-groove ceiling.

Landscaping will be kept to a minimum with traditional, lower, plantings including evergreen shrubs, hydrangea, and garden beds with a variety of native plantings. No trees currently exist on the property and only shrubbery will be removed, making way for construction and new planting.

The driveway will be asphalt and walkways will be pavers with granite landscape steps where needed.

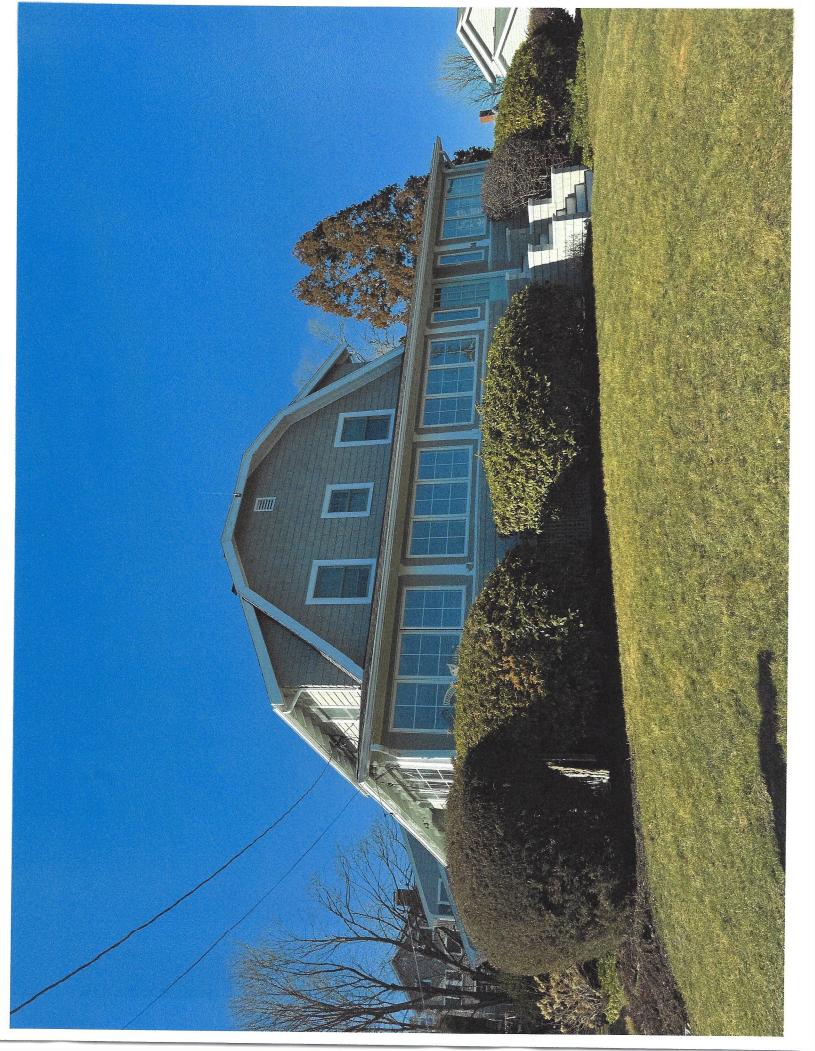

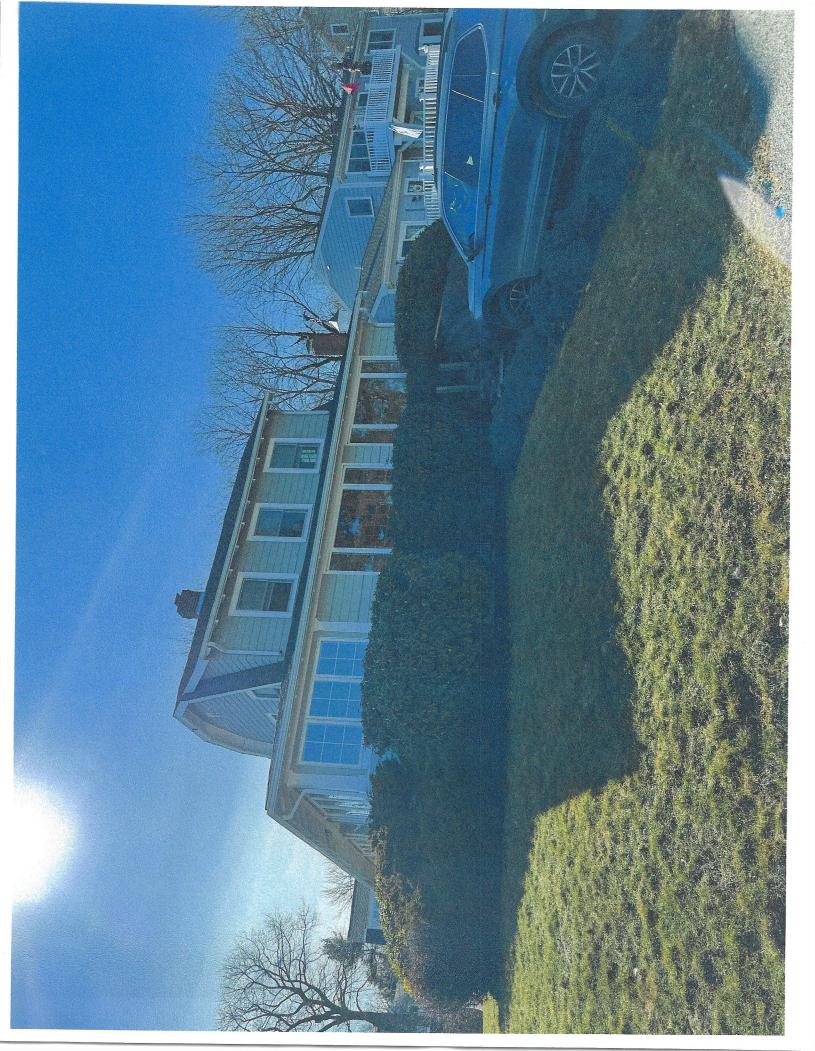



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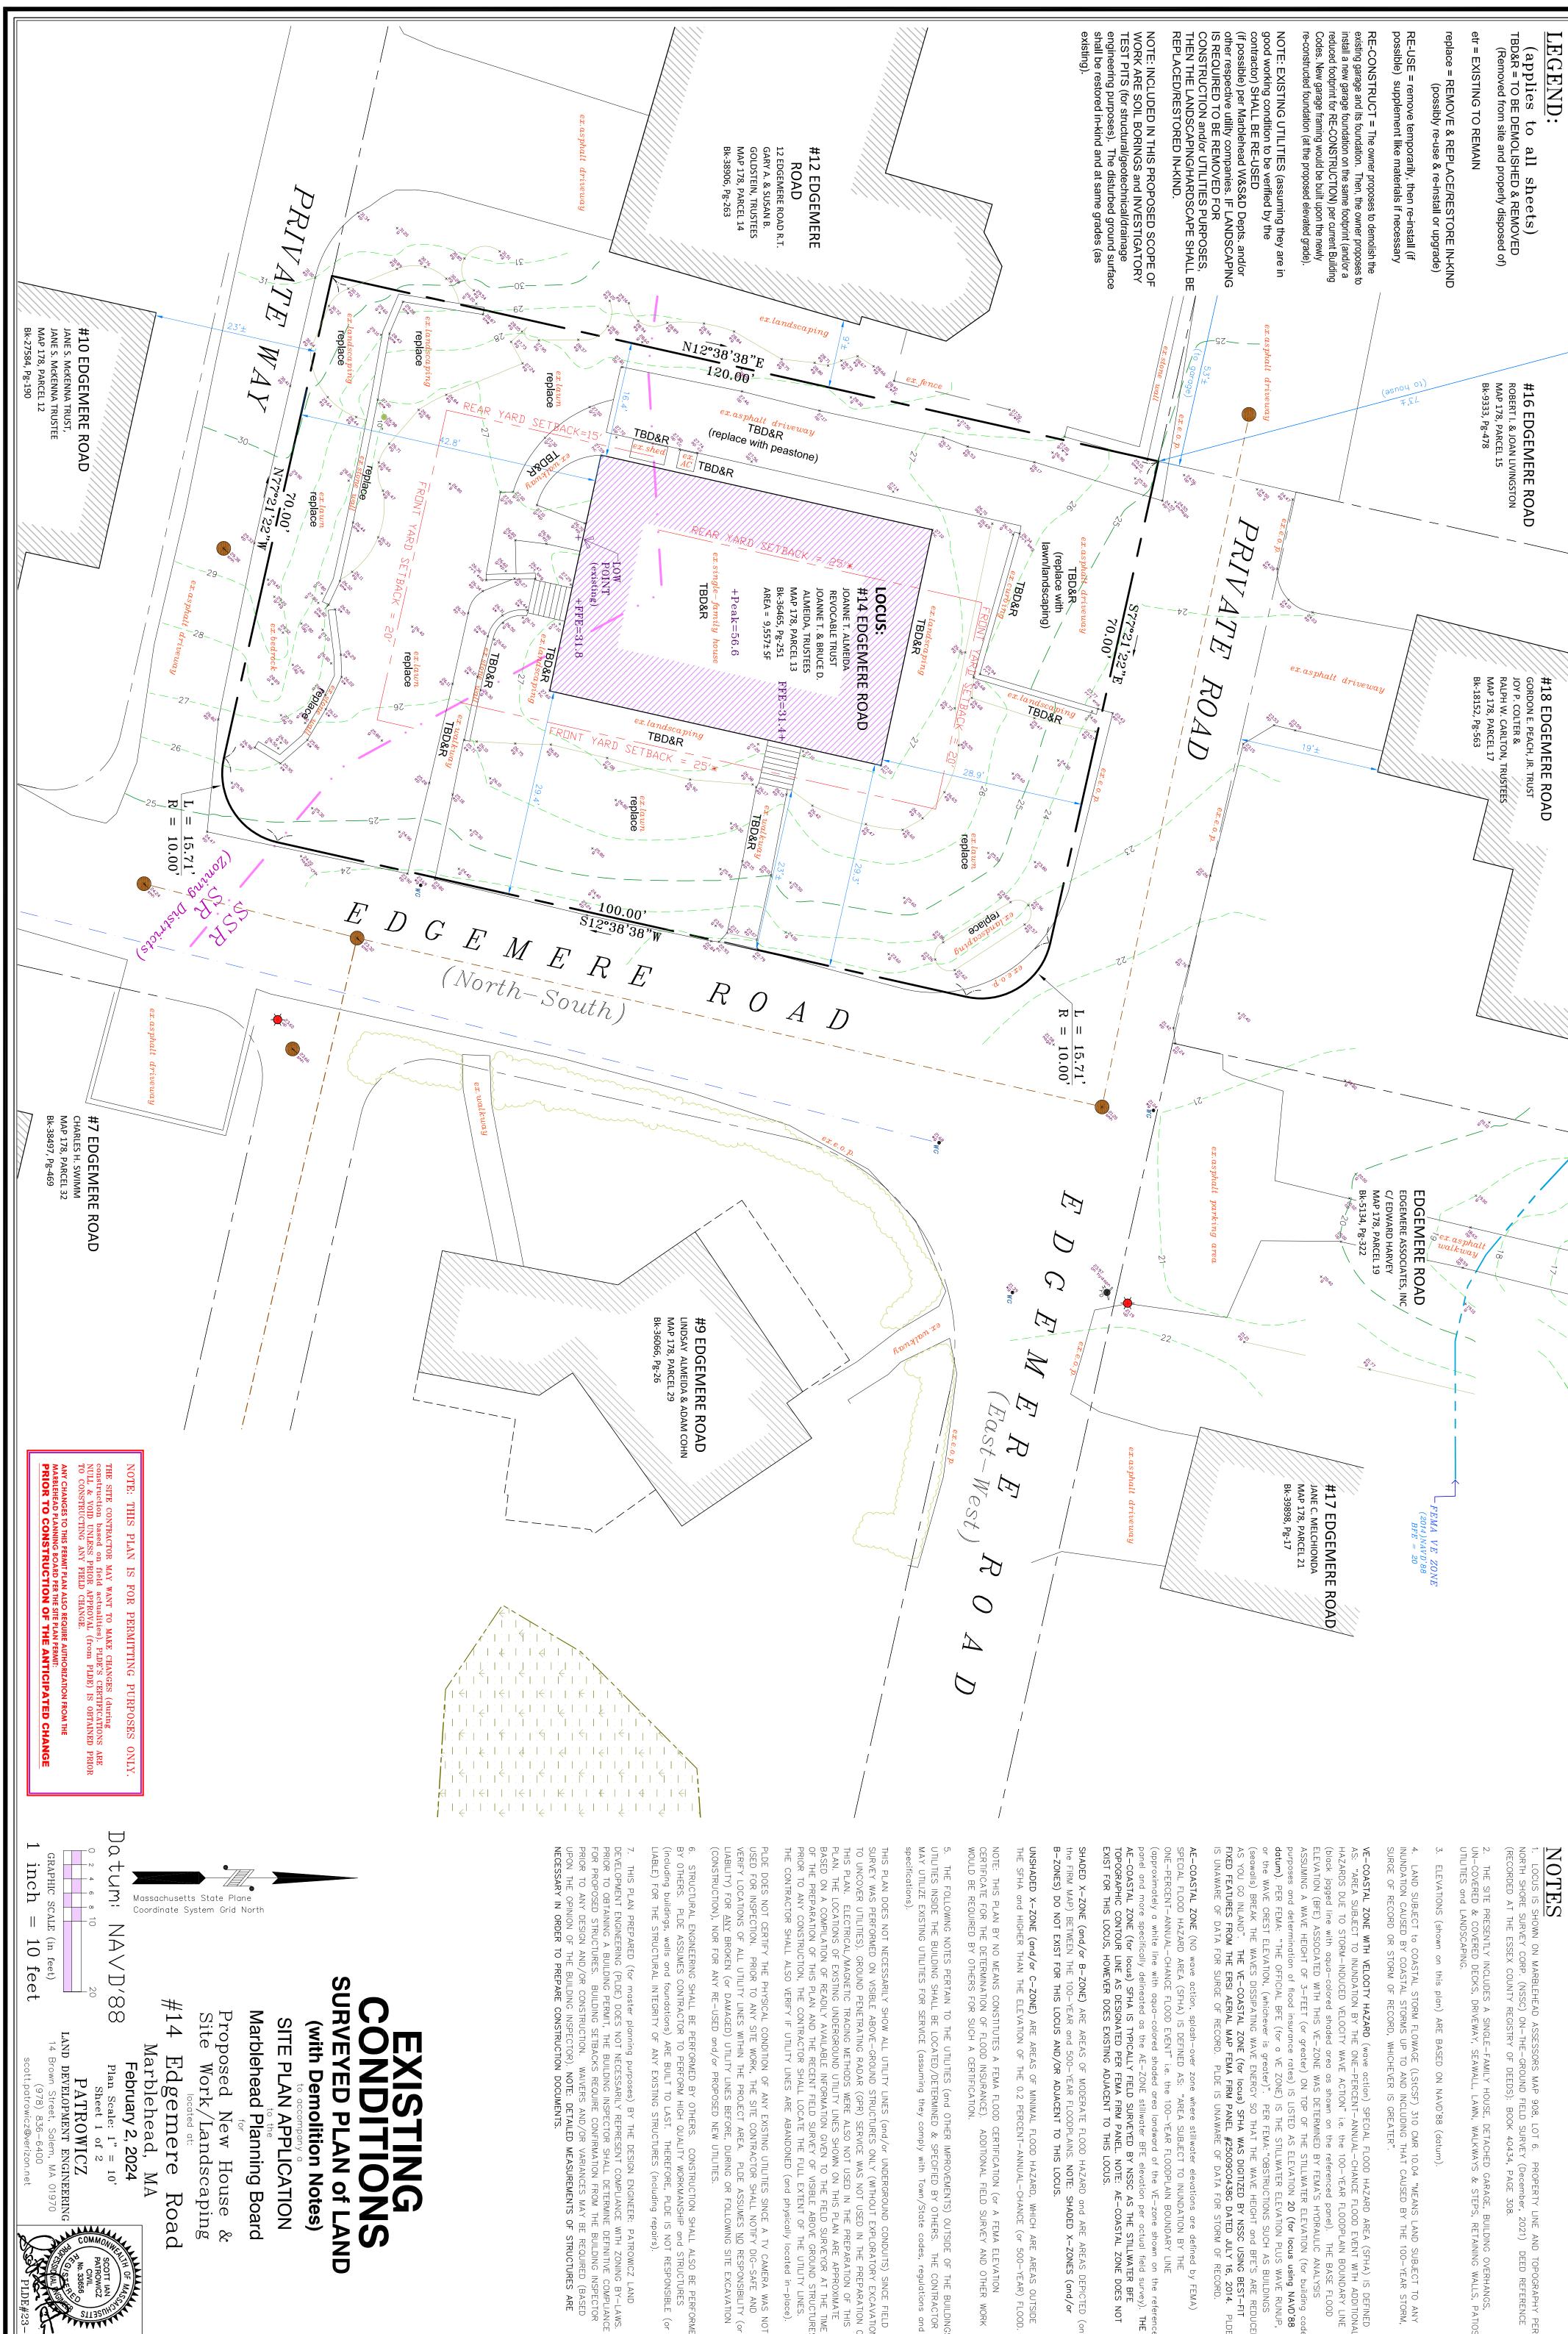
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1. LOCUS IS SHOWN ON MARBLEHEAD ASSESSORS MAP 908, LOT 6. PROPERTY LINE AND TOPOGRAPHY PER NORTH SHORE SURVEY CORP. (NSSC) ON—THE—GROUND FIELD SURVEY (December, 2021) DEED REFERENCE (RECORDED AT THE ESSEX COUNTY REGISTRY OF DEEDS): BOOK 40434, PAGE 308.

2. THE SITE PRESENTLY INCLUDES A SINGLE—FAMILY HOUSE, DETACHED GARAGE, BUILDING OVERHANGS, UN—COVERED & COVERED DECKS, DRIVEWAY, SEAWALL, LAWN, WALKWAYS & STEPS, RETAINING WALLS, PATIOS UTILITIES and LANDSCAPING.

on this plan) ARE BASED ON NAVD'88 (dat

LAND SUBJECT to COASTAL STORM FLOWAGE (LStCSF) 310 CMR 10.04 "MEANS LAND SUBJECT TO ANY JNDATION CAUSED BY COASTAL STORMS UP TO AND INCLUDING THAT CAUSED BY THE 100—YEAR STORM RGE OF RECORD OR STORM OF RECORD, WHICHEVER IS GREATER".

VE_COASTAL ZONE WITH VELOCITY HAZARD (wave action) SPECIAL FLOOD HAZARD AREA (SFHA) IS DEFINED AS: "AREA SUBJECT TO INUNDATION BY THE ONE—PERCENT—ANNUAL—CHANCE FLOOD EVENT WITH ADDITIONAL HAZARDS DUE TO STORM—INDUCED VELOCITY WAVE ACTION" i.e. the 100—YEAR FLOODPLAIN BOUNDARY LINE (black jagged line with aqua—colored shaded area as shown on the referenced panel). THE BASE FLOOD ELEVATION (BFE) ASSOCIATED WITH THIS VE—ZONE WAS DETERMINED BY FEMA'S HYDRAULIC ANALYSIS ASSUMING A WAVE HEIGHT OF 3—FEET (or greater) ON TOP OF THE STILLWATER ELEVATION (for building code purposes and determination of flood insurance rates) IS LISTED AS ELEVATION 20 (for locus using NAVD'88 datum). PER FEMA: "THE OFFICIAL BFE (for a VE ZONE) IS THE STILLWATER ELEVATION PLUS WAVE RUNUP, or the WAVE CREST ELEVATION, (whichever is greater)". PER FEMA: "OBSTRUCTIONS SUCH AS BUILDINGS (seawalls) BREAK THE WAVES DISSIPATING WAVE ENERGY SO THAT THE WAVE HEIGHT and BFE'S ARE REDUCED AS YOU GO INLAND". THE VE—COASTAL ZONE (for locus) SFHA WAS DIGITIZED BY NSSC USING BEST—FIT FIXED FEATURES FROM THE ERSI AERIAL MAP FEMA FIRM PANEL #25009C0438G DATED JULY 16, 2014. PLDE IS UNAWARE OF DATA FOR STORM OF RECORD.

AE-COASTAL ZONE (NO wave action, splash-over zone where stillwater elevations are defined by FEMA) SPECIAL FLOOD HAZARD AREA (SFHA) IS DEFINED AS: "AREA SUBJECT TO INUNDATION BY THE ONE-PERCENT-ANNUAL-CHANCE FLOOD EVENT" i.e. the 100-YEAR FLOODPLAIN BOUNDARY LINE (approximately a white line with aqua-colored shaded area landward of the VE-zone shown on the referen panel and more specifically delineated as the AE-ZONE stillwater BFE elevation per actual field survey). TH AE-COASTAL ZONE (for locus) SFHA IS TYPICALLY FIELD SURVEYED BY NSSC AS THE STILLWATER BFE TOPOGRAPHIC CONTOUR LINE AS DESIGNATED PER FEMA FIRM PANEL. NOTE: AE-COASTAL ZONE DOES NOT EXIST FOR THIS LOCUS, HOWEVER DOES EXISTING ADJACENT TO THIS LOCUS.

SHADED X-ZONE (and/or B-ZONE) ARE AREAS OF MODERATE FLOOD HAZARD and ARE AREAS DEPICTED (or the firm map) between the 100-year and 500-year floodplains. Note: shaded x-zones (and/or B-Zones) do not exist for this locus and/or adjacent to this locus.

UNSHADED X—ZONE (and/or C—ZONE) ARE AREAS OF MINIMAL FLOOD HAZARD, WHICH ARE AREAS OUTSIDE THE SFHA and HIGHER THAN THE ELEVATION OF THE 0.2 PERCENT—ANNUAL—CHANCE (or 500—YEAR) FLOOD

5. THE FOLLOWING NOTES PERTAIN TO THE UTILITIES (and OTHER IMPROVEMENTS) OUTSIDE OF THE BUILDINGS UTILITIES INSIDE THE BUILDING SHALL BE LOCATED/DETERMINED & SPECIFIED BY OTHERS. THE CONTRACTOR MAY UTILIZE EXISTING UTILITIES FOR SERVICE (assuming they comply with Town/State codes, regulations and

IS PLAN DOES NOT NECESSARILY SHOW ALL UTILITY LINES (and/or UNDERGROUND CONDUITS) SINCE FIELD RVEY WAS PERFORMED ON VISIBLE ABOVE—GROUND STRUCTURES ONLY (WITHOUT EXPLORATORY EXCAVATION UNCOVER UTILITIES). GROUND PENETRATING RADAR (GPR) SERVICE WAS NOT USED IN THE PREPARATION OF IS PLAN. ELECTRICAL/MAGNETIC TRACING METHODS WERE ALSO NOT USED IN THE PREPARATION OF THIS AN. THE LOCATIONS OF EXISTING UNDERGROUND UTILITY LINES SHOWN ON THIS PLAN ARE APPROXIMATE ASED ON A COMPILATION OF READILY AVAILABLE INFORMATION GIVEN TO THE FIELD SURVEYOR AT THE TIME THE PREPARATION OF THIS PLAN AND THE RECENT FIELD SURVEY OF VISIBLE ABOVE GROUND STRUCTURES. FOR ANY CONSTRUCTION, THE CONTRACTOR SHALL LOCATE THE FULL EXTENT OF THE UTILITY LINES.

6. STRUCTURAL ENGINEERING SHALL BE PERFORMED BY OTHERS. CONSTRUCTION SHALL ALSO BE PERFORMED BY OTHERS. PLDE ASSUMES CONTRACTOR TO PERFORM HIGH QUALITY WORKMANSHIP and STRUCTURES (including buildings, walls and foundations) ARE BUILT TO LAST. THEREFORE, PLDE IS NOT RESPONSIBLE (or LIABLE) FOR THE STRUCTURAL INTEGRITY OF ANY EXISTING STRUCTURES (including repairs).


7. THIS PLAN PREPARED (for master planning purposes) BY THE DESIGN ENGINEER: PATROWICZ LAND DEVELOPMENT ENGINEERING (PLDE) DOES NOT NECESSARILY REPRESENT COMPLIANCE WITH ZONING BY-IPRIOR TO OBTAINING A BUILDING PERMIT, THE BUILDING INSPECTOR SHALL DETERMINE DEFINITIVE COMPLIANCE PROPOSED STRUCTURES. BUILDING SETBACKS REQUIRE CONFIRMATION FROM THE BUILDING INSPECTOR PRIOR TO ANY DESIGN AND/OR CONSTRUCTION. WAIVERS AND/OR VARIANCES MAY BE REQUIRED (BAS UPON THE OPINION OF THE BUILDING INSPECTOR). NOTE: DETAILED MEASUREMENTS OF STRUCTURES AR NECESSARY IN ORDER TO PREPARE CONSTRUCTION DOCUMENTS.


SURVEYED PLAN of LAND SITE PLAN APPLICATION (with Demolition Notes)

#14 Proposed New House & Site Work/Landscaping Marblehead, Marble Edgemere MARoad

Marblehead Planning Board

PATROWICZ
LAND DEVELOPMENT ENGINEERING
14 Brown Street, Salem, MA 01970 1" = 10' of 2

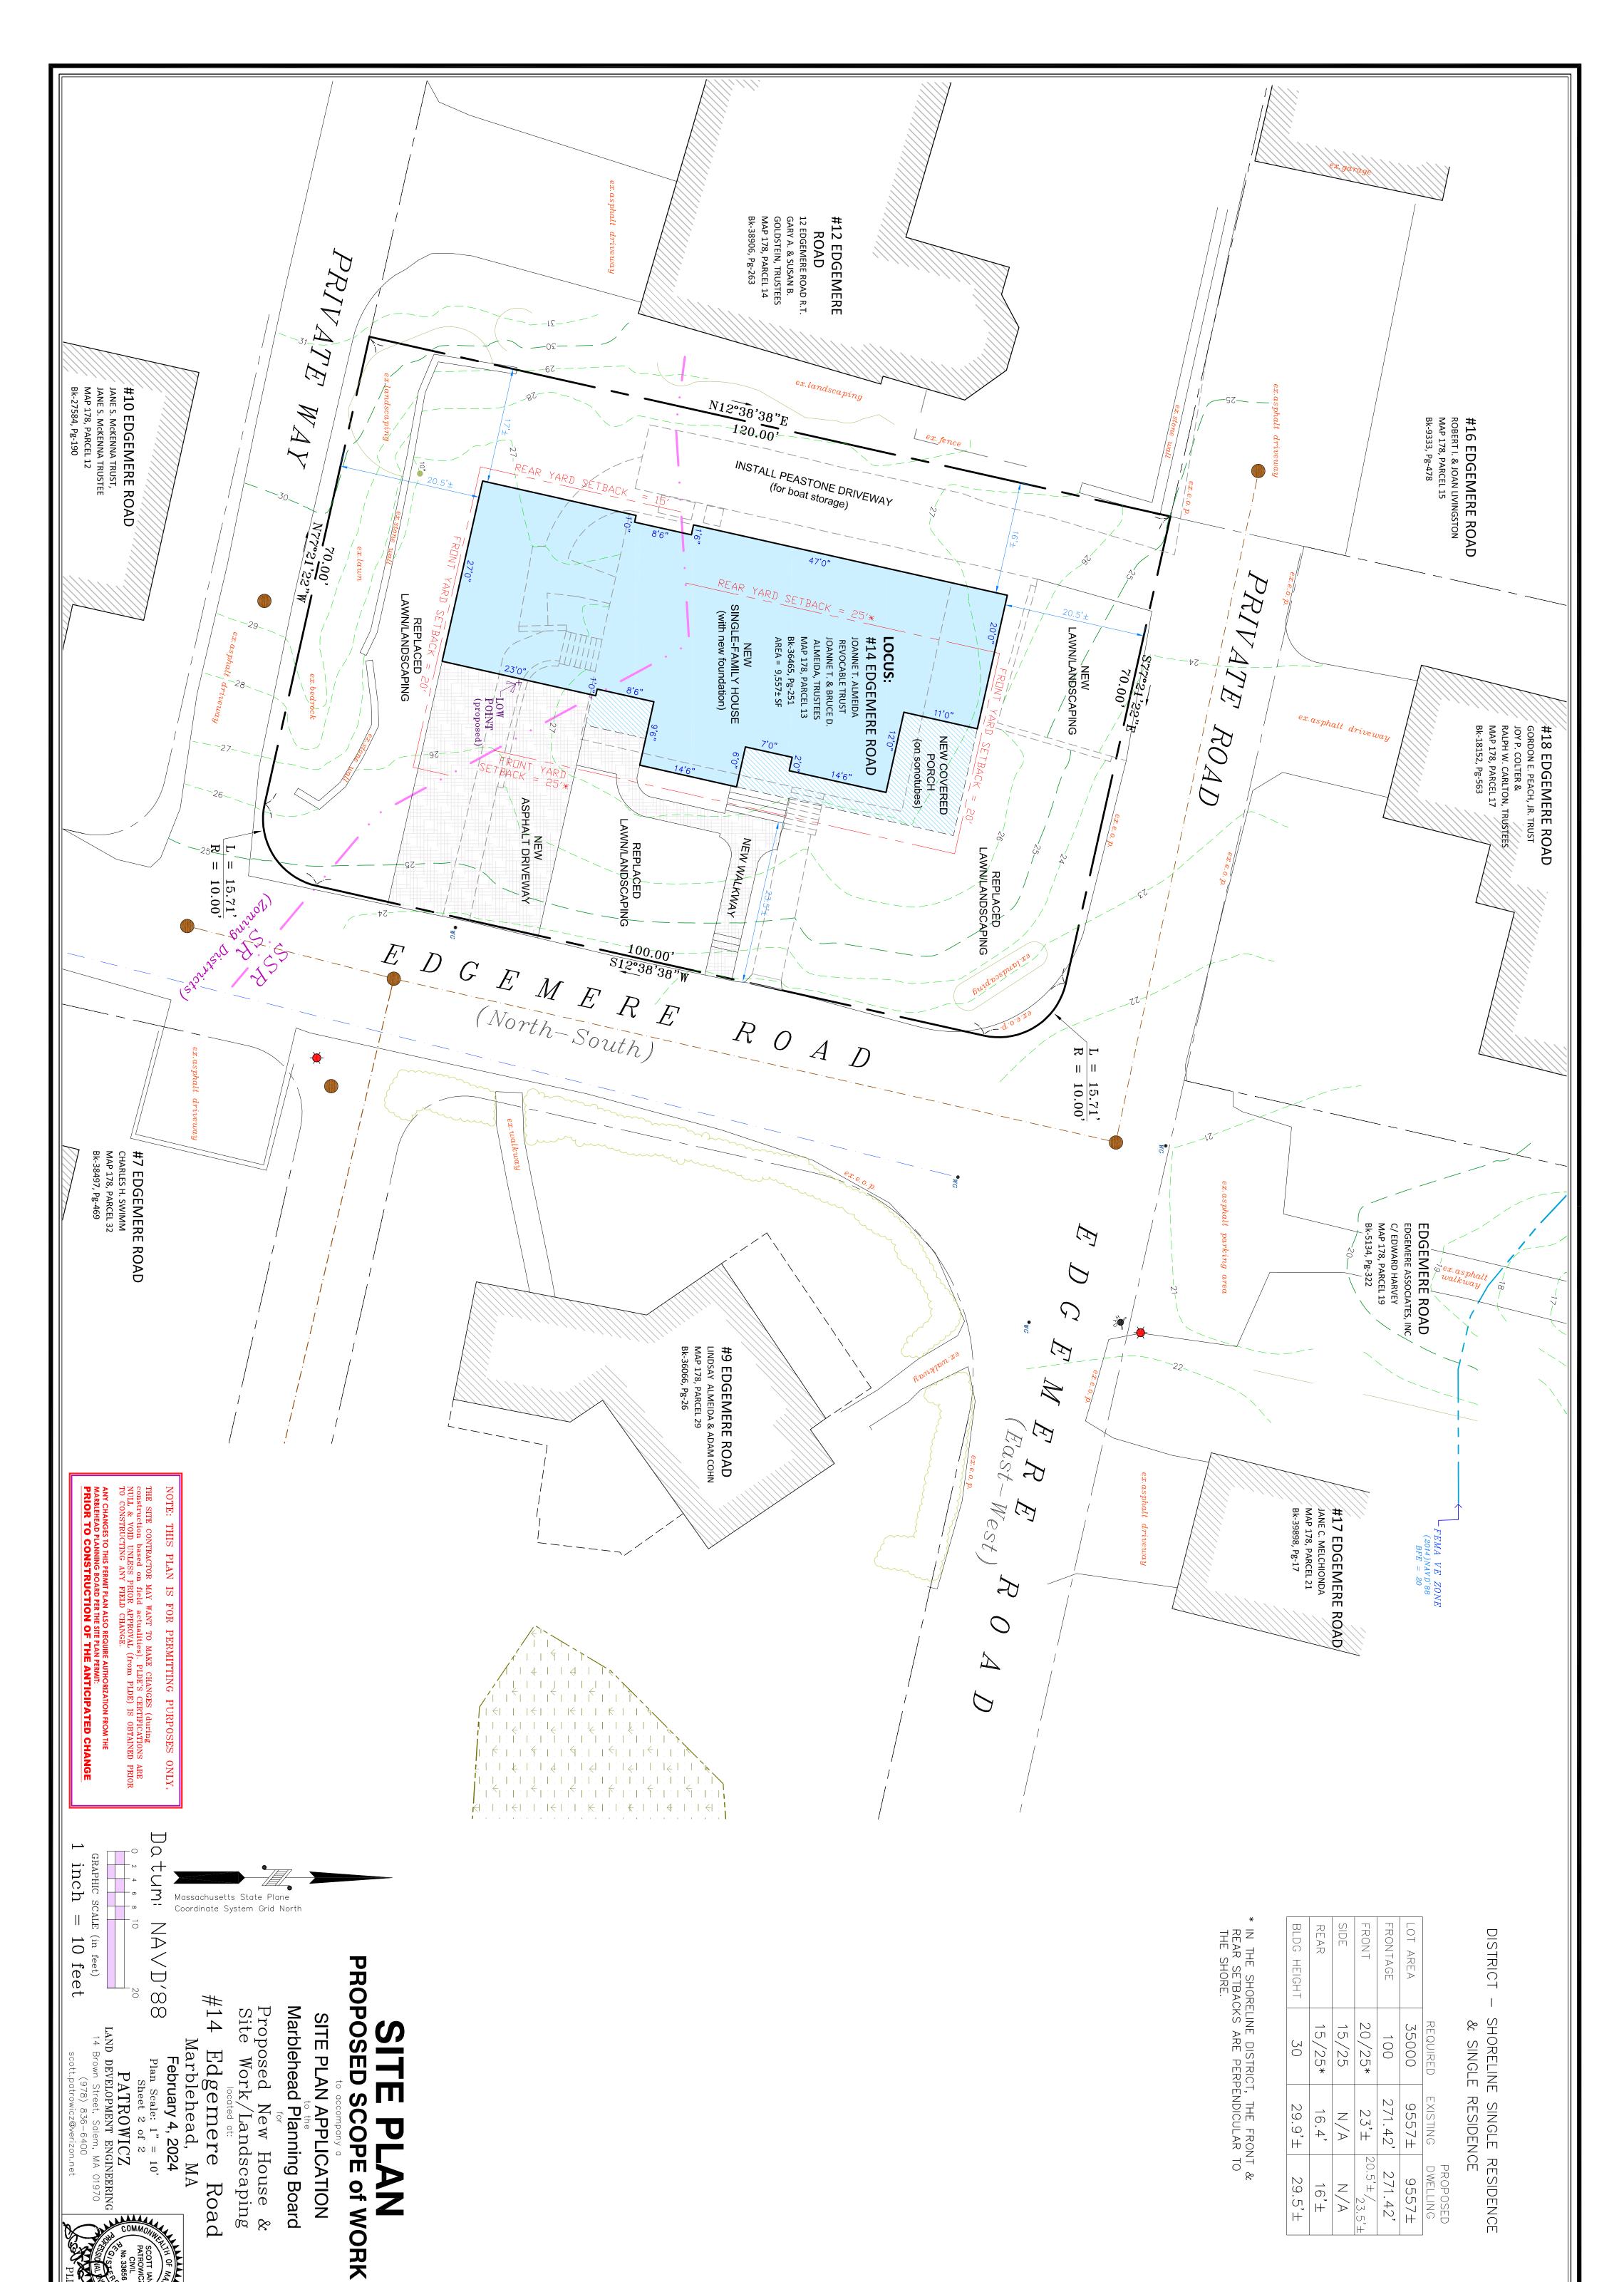

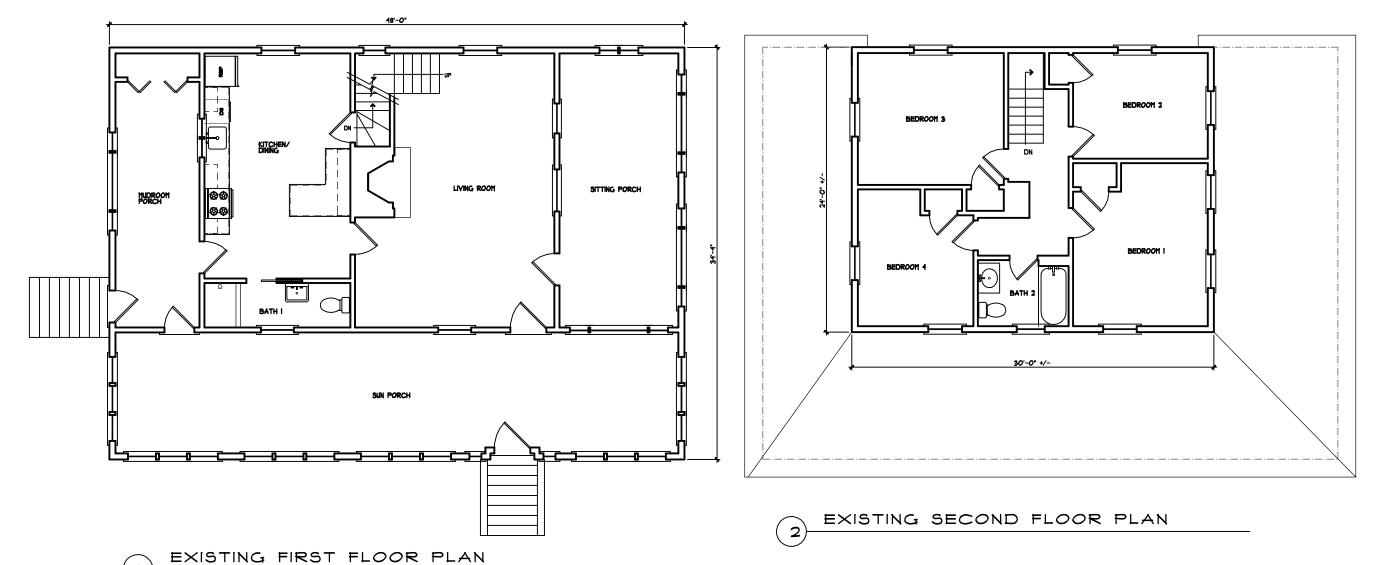

ALMEIDA RESIDENCE 14 EDGEMERE ROAD MARBLEHEAD, MASSACHUSETTS

TAPROOT DESIGN INC.

37 Birch Street Marblehead, MA 01945

Tel 781.639.4616 Cell 781.864.2304

1/8"=1'-0" scale: 02/12/24 date:

drawn by:

VLH



41'-0" 23'-0" BILCO PERMENTRY BULKHEAD, FIELD-VERIFY SIZE W.L.C. **GUEST BEDROOM** 1/2 BATH I 2-CAR GARAGE FOYER PORCH T'-0"

FIRST FLOOR PLAN

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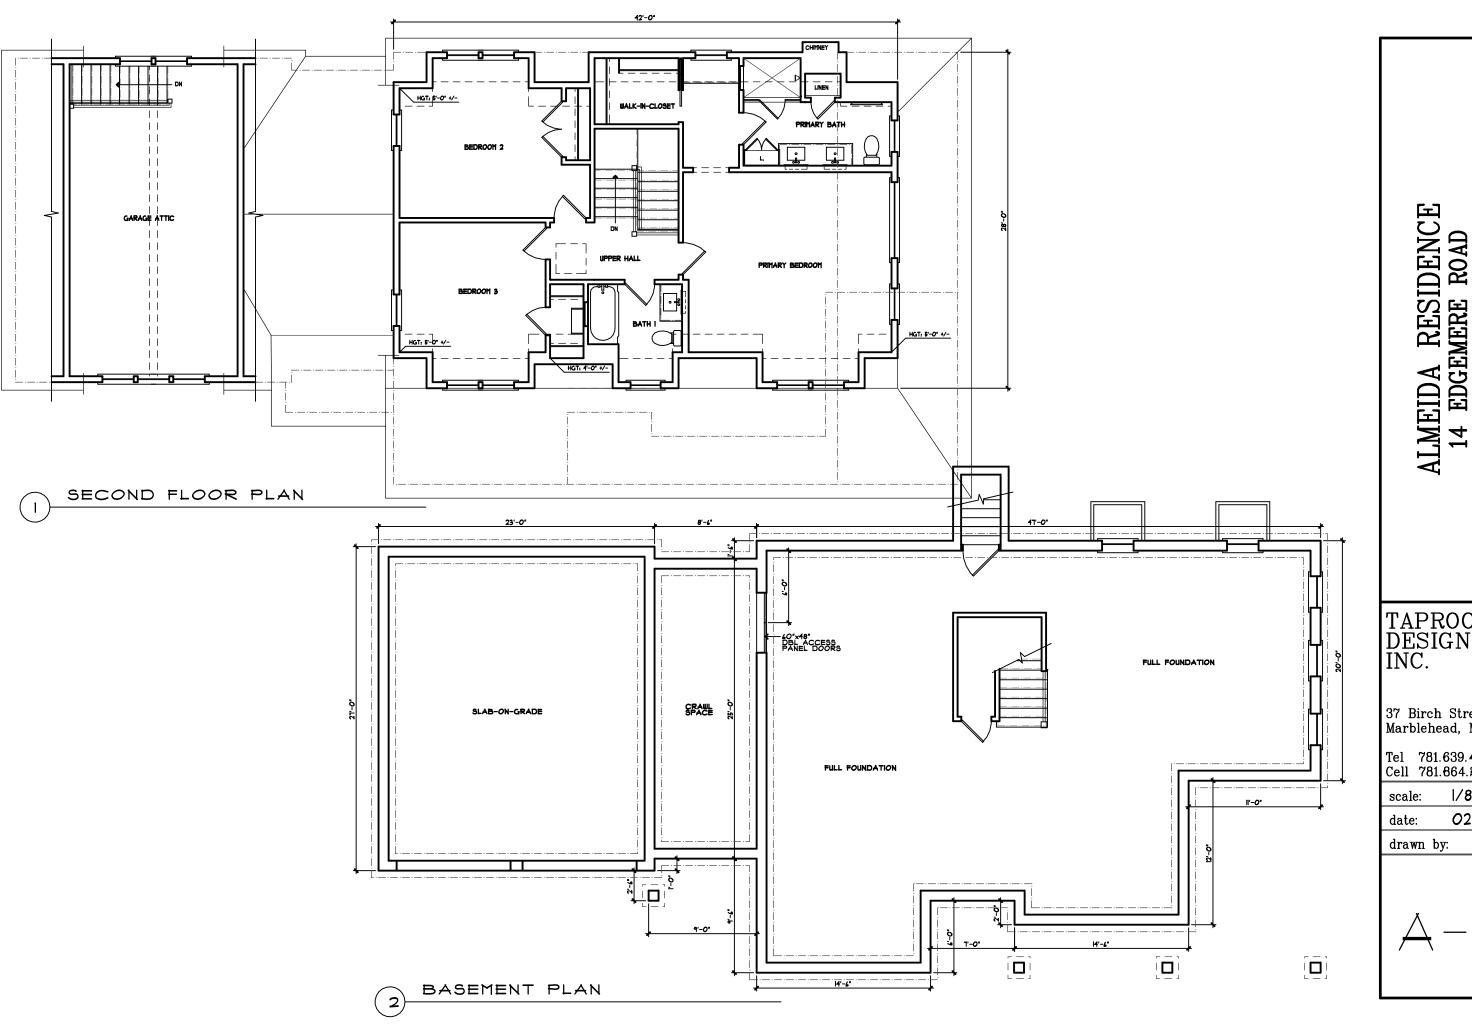
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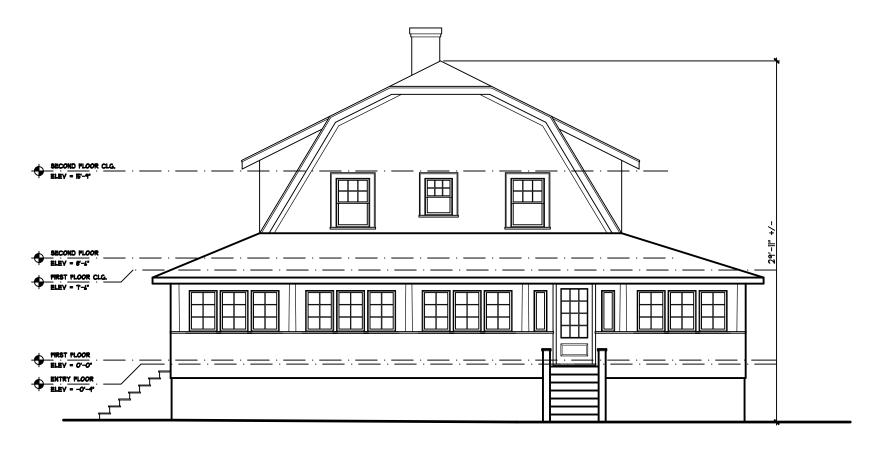
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EXISTING FRONT ELEVATION



2 EXISTING RIGHT SIDE ELEVATION

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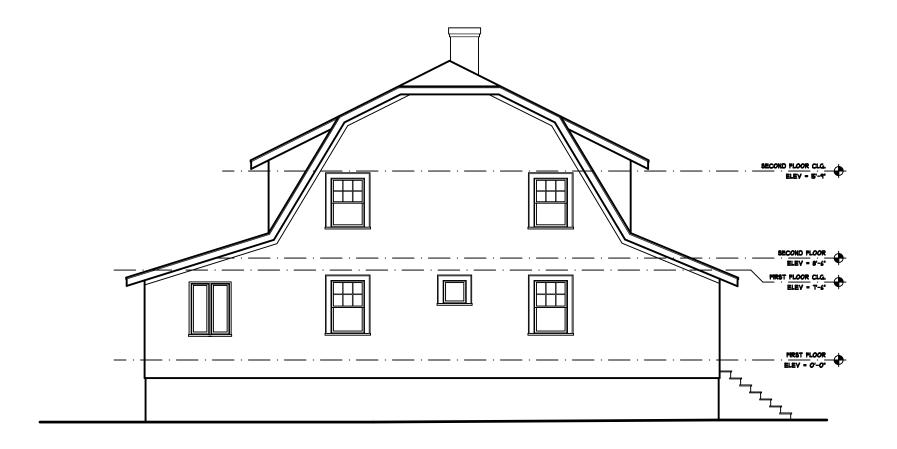
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 $\triangle - 2$



SECOND ROOR ELEV - F-7 PRET ROOR ELEV - O-0-

EXISTING REAR ELEVATION

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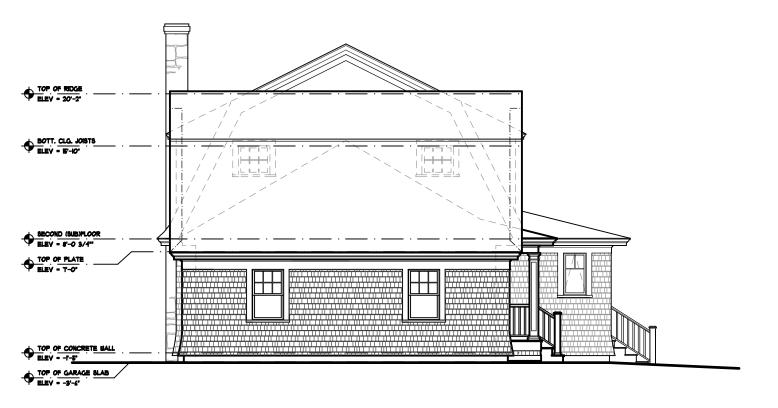
drawn by: VLH

EX-3

2

EXISTING LEFT SIDE ELEVATION





2 LEFT SIDE ELEVATION

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A-3