## TOWN OF MARBLEHEAD SITE PLAN APPROVAL APPLICATION PLANNING BOARD

Property Address: <u>84 Harbor Ave</u> 1. Assessor Map 918 Lot 3 & 3A 3. Zoning District SESR 2. Applicant: Jerome & Holly O'Neill 4. Applicant's Address 18 Orchard Street, Marblehead, MA 5. Telephone Number: <u>617-434-7730</u> (Daytime) <u>978-968-5133</u> (Evening) 6. Email address: hollyaoneill@gmail.com 7. Applicant's Representative Paul Feldman, Tobin Shulman 7. List other permits required and status (e.g. Old & Historic Districts, Conservation, 8. Board of Appeals, etc., obtained, scheduled, etc.) Conservation Commission - Public hearing opened 9/14/23, ongoing Board of Appeals - Application in process of Owner) O'HEILL (Date)

Address 18 Orchard Street

Marblehead, MA

(Signature of Owner)

Phone: 978-968-5133

## FOR TOWN USE ONLY

Application Received \_\_\_\_\_\_ Submittal Deemed Complete \_\_\_\_\_

Waivers

Scheduled Hearing Date \_\_\_\_\_\_ File Number \_\_\_\_\_



Planning Board Narrative

Jerome and Holly O'Neill 84 Harbor Ave Marblehead, MA 01945


The property located at 84 Harbor Ave is in the Shoreline Expanded Single Residence (SESR) Zoning District. The lot has a pre-existing non-conforming single-family dwelling on the lot.

The owners propose the demolition of the existing home, and the construction of a new single family home, moved back on the lot and set within the setback requirements. The foundation of the existing home will partially remain, as it is integrated with the seawall.


The project has been designed to respectfully address the neighborhood, town infrastructure and natural resources as more particularly described below.

- a) The architectural and design features are in harmony with the prevailing character and scale of buildings in the neighborhood and town (such as but not limited to: building materials, screening, breaks in roof and wall lines, adequate light, air, circulation and separation between buildings).
  - The architecture of the proposed home features gable roofs in keeping with the architecture of other dwellings in the area.
  - The massing of home has been broken up into three sections, to reduce the overall scale of the structure, provide breaks in roof and wall lines, and provide architectural and visual interest.
  - The proposed project includes natural materials that are historically and customarily used in home construction in the area, specifically a wood shingled roof, standing seam metal roof accents, cedar shingle siding and painted trim.
  - The proposed home meets building setback and height restrictions, which are intended to allow for adequate light, air, and separation between buildings.
- b) The character of the site is preserved (such as but not limited to: protection of historical and natural resources and existing terrain, minimization of grade changes, tree and soil removal).
  - The general character of the site will be preserved and enhanced. The general slope and grading on the site will largely remain unchanged. The existing house is built within the conservation resource area, while the proposed home is sited back from the ocean toward Harbor Ave. The amount of pervious and planted area within the resource area and buffer zones will be increased. There are minor grade changes related to the driveway.
- c) Vehicular and pedestrian movement within the site are convenient and safe (such as but not limited to: traffic patterns, circulation, location of driveway openings, parking, loading, access by emergency vehicles, and visibility of and identity of street address numbers).
  - There are no additional traffic patterns on the property as now comprised or after the proposed new home construction.

- The driveway will be largely in the same location as the existing, with a new parking court on the upland side of the home.
- d) External emissions from the site are minimized or eliminated (such as but not limited to: erosion, surface water runoff, pollution, sewage, disposal of refuse, odors, noise, glare, light and any other environmental impacts).
  - The new single family dwelling will minimize emissions from the site.
  - Surface water runoff from the property will be managed using best practices including rain gardens, as further detailed in the conservation application.
- e) The adverse effects on abutting lots, the immediate neighborhood and the Town of Marblehead are minimized including (such as but not limited to: conflicts between residential, commercial and industrial uses, obstructions of views, increases in use of Town services and impact on Town infrastructure).
  - The proposed new single family home will not change the impact on the Town services or infrastructure. There is no change in use, and the conformity to zoning requirements for the new structure will preserve slot views from the public way.

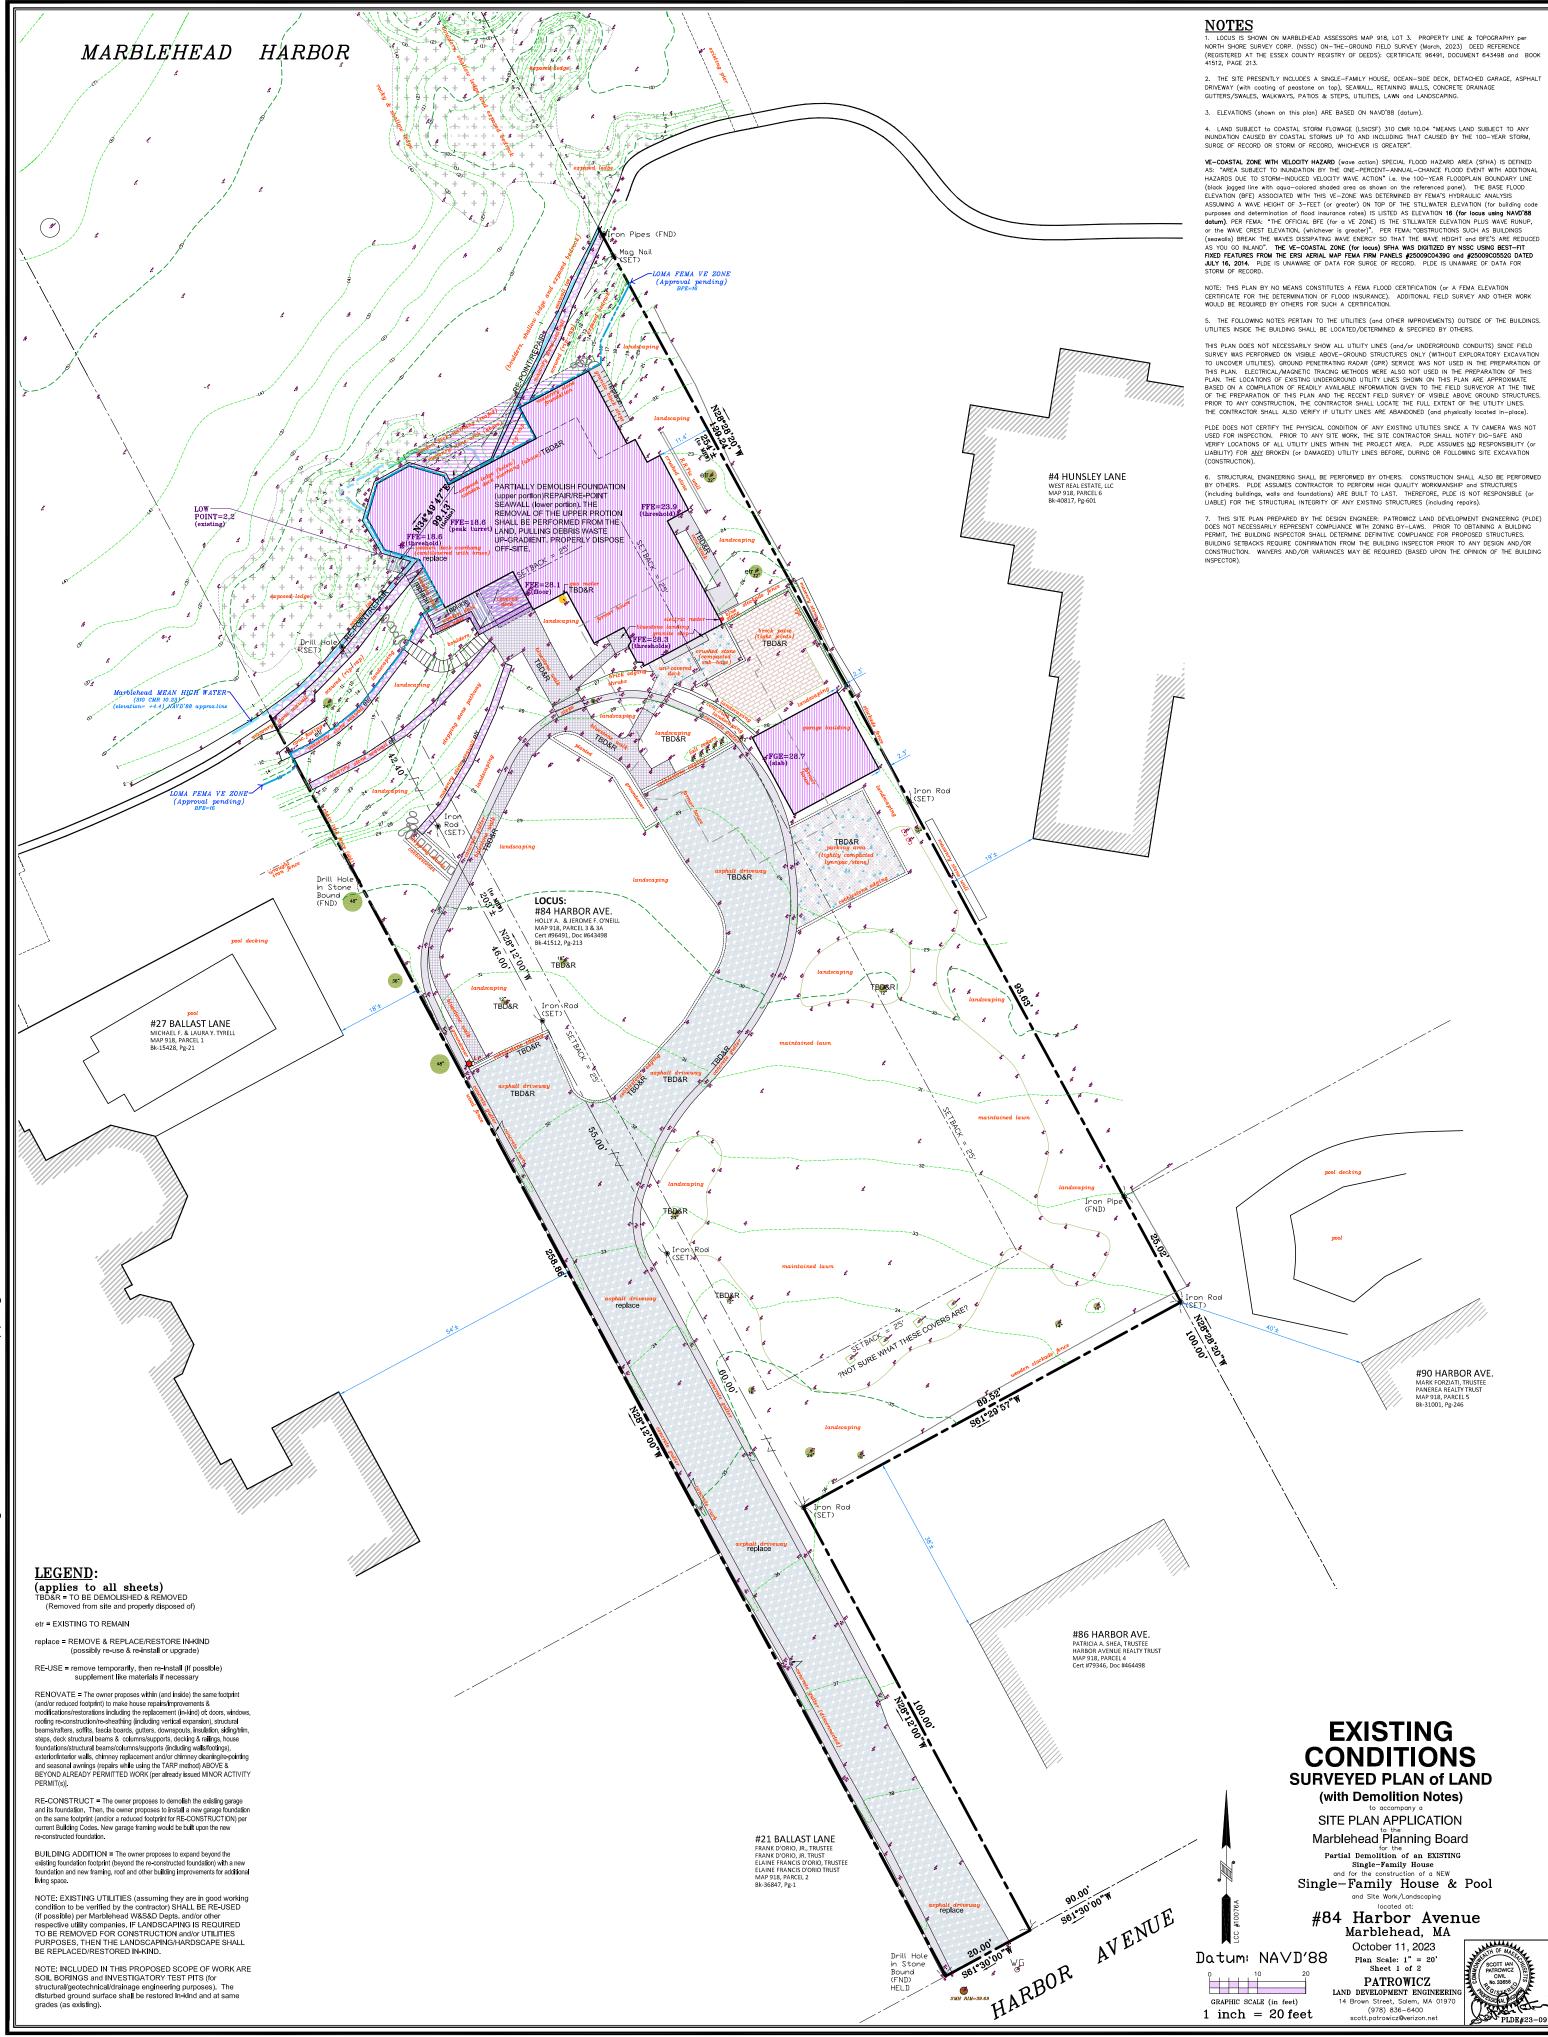




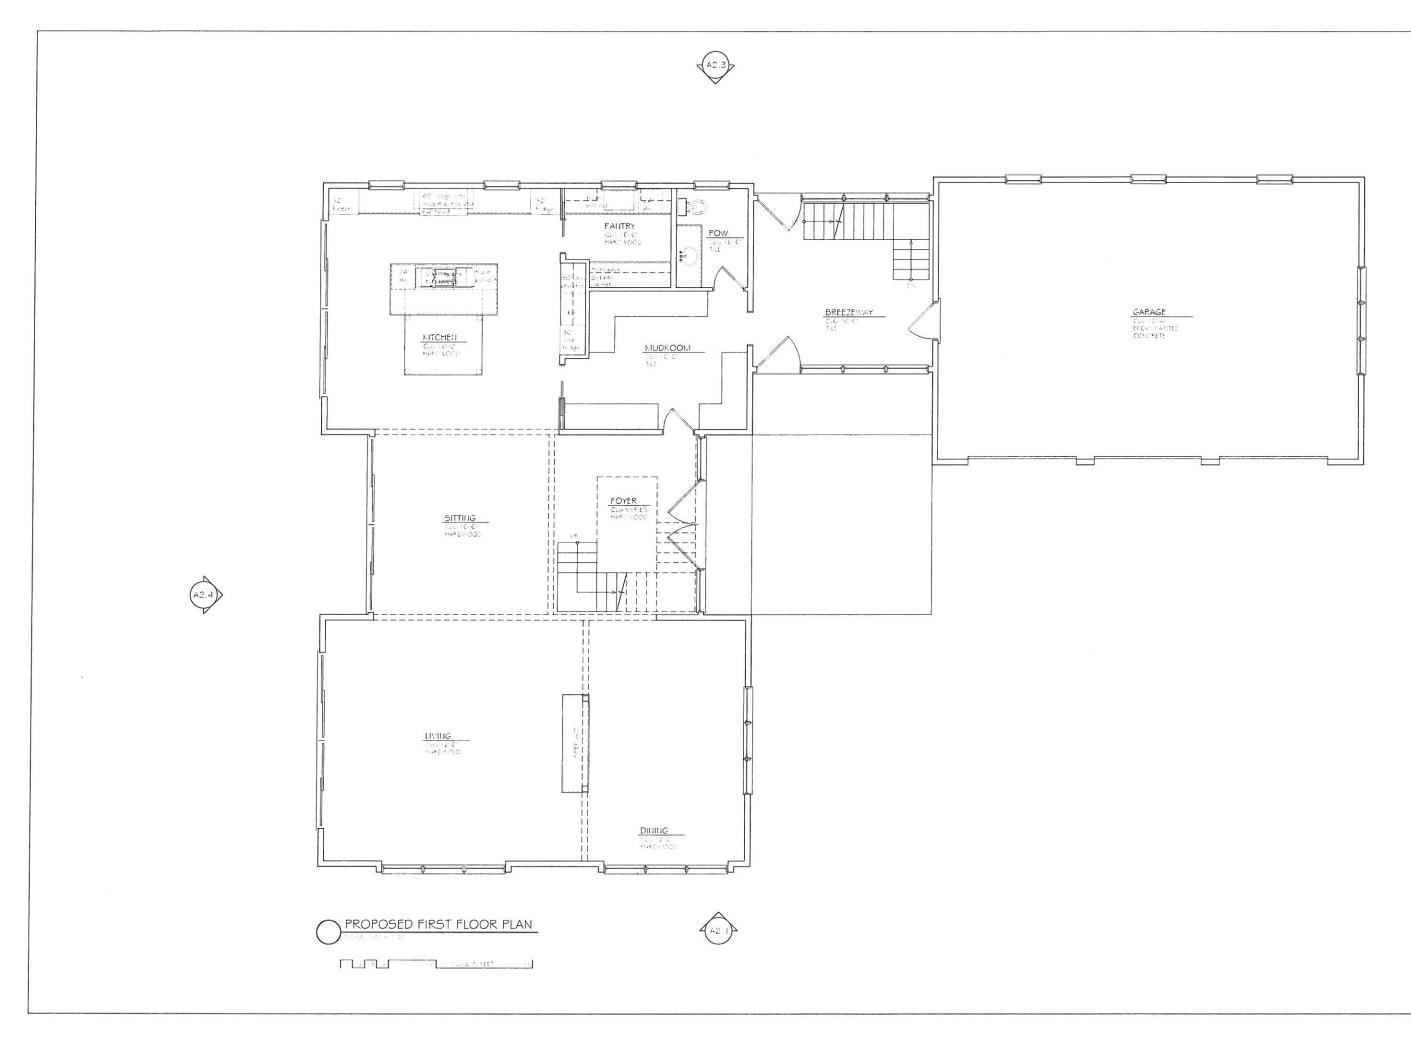

Proprised Renovations and Additions to	PROPOSED FIRST	Revisions		
V O'Neill Residence		a Coscrethion	Date Da	
	FLUOK FLAN			F V
V R4 Harbor Ave Marbleheod MA				AI.
DESTGNUT LIATUUT LIVE, INTALUICILCAU, INIT	Scale: $1/8^{"} = 1^{-}0^{"}$			ľ
SV DFSIGN 126 Doter Street Barrely Marca muets 0.915 Access 646 and 23 878 627 836	Drawn By T_Shulman Checked By T_Shulman			
	Date 10/16/2023 Protect #			



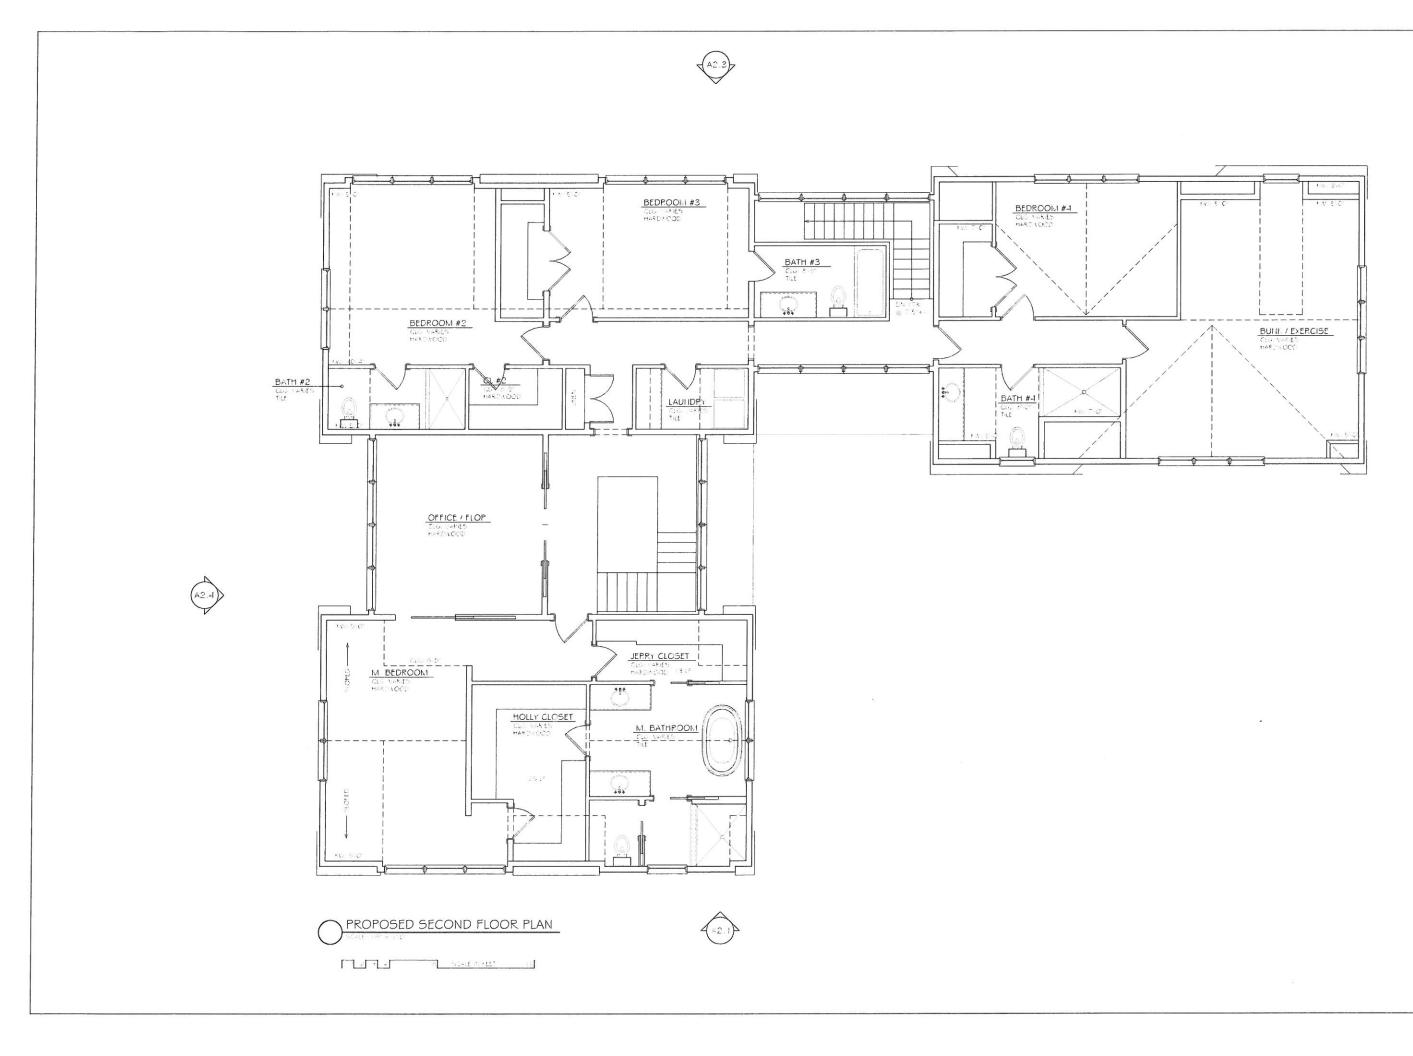

Proposed Renovations and Additions to	and Additions to	PROPOS	PROPOSED SECOND	Revisions		
I lielli	V O'Neill Residence			# Description	Date Da	Γ
		FLOOR PLAN	PLAN			<
I Have	81 Harbor Aris Marhlahand MA					LA.
T IIAIU	UI TAVE, IMAI UICIICAU, IMITA	Scale: $1/8" = 1'-0"$				- 
C L C L C L C L C L C L C L C L C L C L	126 Dudies Start Barnetly Marca an orce01015 Arrest support on 1.676 0246	Drawn By: T_Shulman	Drawn By T_Shulman Checked By T_Shulman			Γ
		Date 10/16/2023	Project #			Γ







	A2.2
	Revisions
	PROPOSED STREET ELEVATION sale 18" = 1-0" Daw Br. T. Shulman Dav. 10-10-2023 Protect #
	Proposed Renovations and Additions to   O'Neill Residence   DESIGN   SV Design LLC.
-	DESIGN





Proposed Renovations and Additions to	dditions to	DDODGED OCEAN	Revisions		
■ V O'Neill Residence	idence	E EVITORED OUEAN	an ang ang ang ang ang ang ang ang ang a	D.900 (24	11
		ELEVALION			7 6 V H
84 Harbor	1	Scale 1/8" = 1'-0"		_	
SV DECICIN	10 Ded to Conset Description of Manufacture 10 0000	Drawn Bv. T. Shuliman Checked Bv. T. Shuliman			T
	det/STUTES of the state of the state of a local determinant of the state of the state of the state of the state	Date 10/16/2023 Protect #			Г

