


tel: 781-631-1529

fax: 781-631-2617 Revision Date: 12-02-20

Town of Marblehead **ZONING BOARD OF APPEALS**

Mary A. Alley Municipal Building 7 Widger Road, Marblehead, MA 01945

ZBA APPLICATION

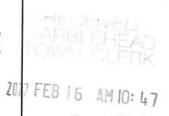

PAGE 1 of 3

Project Address 15 Roosevelt Avenue	
Assessor Map(s) 135 P	arcel Number(s) 26
OWNER INFORMATION	
Signature	date
Name (printed) Loretta Lang	
Address 15 Roosevelt Avenue, Marblehead	, MA 01945
Phone Numbers: home 617-312-1822	work
E-mail langloretta@aol.com	fax
APPLICANT or REPRESENTATIVE IN	FORMATION (if different from owner)
Signature	date 2-11.22
Name (printed) Loretta Lang	
Address c/o Paul M. Lynch, Esq., Zero Sprir	ng Street, Marblehead, MA 01945
Phone Numbers: home Cell 781-704-8559	work 781-631-7808
E-mail lynch@marbleheadlaw.com	fax
	REQUESTED (attach additional page if necessary)
Special Permit to construct an addition to	o an existing non conforming single family dwelling on
on a lot with less than the required lot area,	frontage front and side yard setbacks and less than the
required open area.The addition will exceed	
Please schedule a Zoning / Application review	w with the Building Department by calling 781-631-2220.
- Colain the Town Cierk's stamp and submit 12	copies of each of the following to the Town Engineer's Office.
o the signed and sumped application (3	pages):
 current survey plan (not older than 90 the project design plans as required; 	days) as prepared by a Registered Professional Land Surveyor;
o check for the applicable fee payable to	
• Any relevant permit(s) that were previously is	sued must be available for review by the Board of Appeals at the
scheduled hearing. (Section 3(D), Board of Zon	ning Appeals Rules & Regulations).

View Bylaws - (Chapter 200, Zoning) - online at: www.marbleheast.org/

1. Building Commissioner (pages 1, 2 and 3)

2. Town Clerk's stamp (upper right corner)

REQUIRED SIGNATURES

Town of Marblehead <u>ZBA-APPLICATION</u> Page 2 of 3


LICATION Revision Date: 12-02-2020

Project Address 15 Roosevelt Avenue	Map(s) / Parcel(s) 135/26
ZONING DISTRICT (circle all that apply)	
B B1 BR CR SCR ECR GR SGR	SR SSR ESR SESR HBR U SU
CURRENT USE (explain) Single Family Dweling	
CURRENT USE CONFORMS TO ZONING (Article IV	/, Table 1)
Yes X No (explain)	
PROPOSED CHANGE OF USE	
No X Yes (explain)	
PROPOSED CONSTRUCTION QUALIFIES AS "Bu	ilding New" (§200-7) Yes No X
EXISTING DIMENSIONAL NON-CONFORMITIES X Lot Area - Less than required (§200-7 and Table 2) X Lot Width - Less than required (§200-7) X Frontage - Less than required (§200-7 and Table 2) X Front Yard Setback - Less than required (Table 2) Rear Yard Setback - Less than required (Table 2) X Side Yard Setback - Less than required (Table 2) Height - Exceeds maximum allowed (§200-7 and Ta X Open Area - Less than required (§200-7, §200-15.B X Parking - Less than required; undersized; andem (§ Other Non-conformities (explain) No Existing Dimensional Non-conformities NEW DIMENSIONAL NON-CONFORMITIES (check Lot Area - Less than required (§200-7 and Table 2) Lot Width - Less than required (§200-7) Frontage - Less than required (§200-7 and Table 2) Front Yard Setback - Less than required (Table 2) Rear Yard Setback - Less than required (Table 2) X Side Yard Setback - Less than required (Table 2)	ble 2) (2) and Table 2) 200-17 to §200-21) (circle all that apply) a all that apply)
Height - Exceeds maximum allowed (§200-7 and Ta	ble 2)
X Open Area - Less than required (§200-7, §200-15.B Parking - Less than required; undersized; tandem (§200-7, §200-15.B Parking - Less than required; undersized; tandem (§200-7, §200-15.B Parking - Less than required; undersized; tandem (§200-7, §200-15.B Parking - Less than required; undersized; tandem (§200-7, §200-15.B Parking - Less than required; undersized; tandem (§200-7, §200-15.B Parking - Less than required)	200-17 to \$200-21) (circle all that apply)
X Exceeds 10% Expansion Limits for Non-confo	rming Building (§200-30.D)
Other Non-conformities (explain)	
No New Dimensional Non-conformities	
ADDITIONAL HEARINGS REQUIRED	d by ment
	No X (Superport)
Historic District Commission Yes	No X Rend Dind als
Conservation Commission Yes Historic District Commission Yes Planning Board Yes	No X No X No X No X REGULATIONS (Sections 3(A) and 3(C))
DESIGN & SURVEY PLANS MEET -ZBA- RULES &	REGULATIONS (Sections 3(A) and 3(C))
Yes X No (explain)	
Building Official	Data 2-16-2022

Town of Marblehead <u>ZBA-APPLICATION</u> Page 3 of 3

Revision Date: 12-02-2020

Project Address 15 Roosevelt Avenue	_ Map(s) / Parcel(s	135/26
NET OPEN AREA (NOA)	EXISTING	<u>PROPOSED</u>
Lot area $= A$	4,125	4,125
Area of features footprint of accessory building(s)	256	256
footprint of building	864	1,144
footprint of deck(s), porch(es), step(s), bulkhead(s)	360	138
number of required parking spaces 2 x (9'x 18' per space)	324	324
area of pond(s), or tidal area(s) below MHW	0	0
other areas (explain)	0	0
Sum of features $= B$	1,804	1,862
Net Open Area $(NOA) = (A - B)$	2,321	2,262
GROSS FLOOR AREA (GFA)		
accessory structure(s)	256	256
basement or cellar (area >5' in height)	663	663
1st floor (12' or less in height) NOTE: [for heights exceeding	786	1,066
2nd floor (12' or less in height) 12' see definition	663	943
3rd floor (12' or less in height) of STORY §200-7]	0	0
4th floor (12' or less in height)	0	0
attic (area >5' in height)	0	0
area under deck (if >5' in height)	0	0
roofed porch(es)	0	0
Gross Floor Area (GFA) = sum of the above areas	2,368	2,928
<u>Proposed total change in GFA</u> = (proposed GFA - existing Gl	FA)	= 560
Percent change in GFA = (proposed total change in GFA ÷ exi	sting GFA) x 100	= 24 %
Existing Open Area Ratio = (existing NOA ÷ existing GFA)		= 1: .98
<u>Proposed Open Area Ratio</u> = (proposed NOA ÷ proposed GFA	A)	= 1:.77
This worksheet applies 1. plan by/dated Twomey Design 2/14 to the following plan(s): 2. plan by/dated Stephen M. Melesciuc 3. plan by/dated	4/2022 2/10/2022	Francisco De la Role d
Building Official //////	Date	-16-202Z

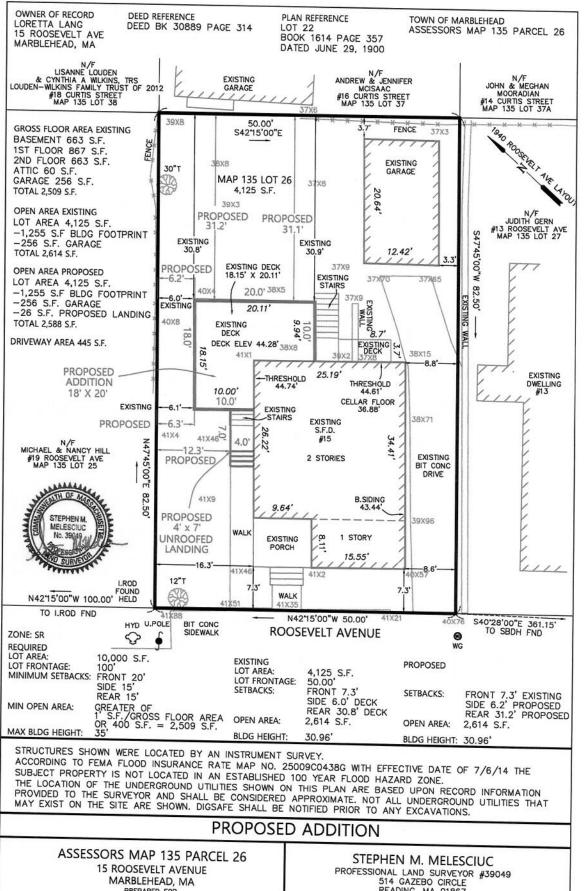


PREPARED FOR LORETTA LANG 15 ROOSEVELT AVE MARBLEHEAD, MA

514 GAZEBO CIRCLE READING, MA 01867 (781)844-7108


SCALE: 1"=10'


DATE: FEBRUARY 8, 2022

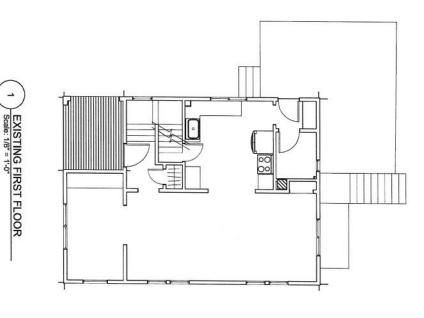



(781) 942-0146	23 California Road Reading, MA 01867		DESIGN	TWOMEY
© 2022 Nancy J. Twomey	Sheet No. 1	Date: 2	Sheet Title: First Floor Plans	LANG RESIDENCE 15 Roosevelt Ave., Marblehead
cy J. Two	_	213.22	Fist Fi	ANG RE
riey	9		or Plans	LANG RESIDENCE osevelt Ave., Marbi
	7		3000	Elehead

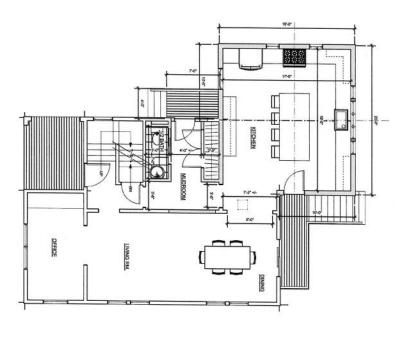


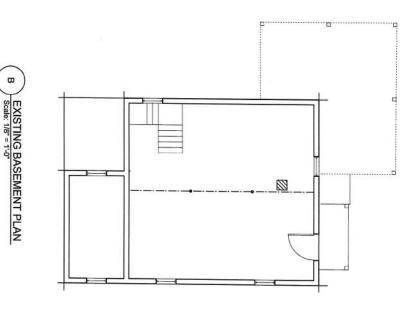




	+-	18-4	, ————————————————————————————————————	<u></u>
+	10-0"		GRAWL SPACE	20-0
		×	ACCESS DOOR	
			10-47	- →
	-			

(781) 942-0146	23 California Road Reading, MA 01867 (781) 942-0146		DESIGN	TWOMEY
© 2022 Nancy J. Twomey	Sheet No.	Date:	Sheet Title: Basement Plans	15 Roo
cy J. Two	2	2.14.22	Baseme	LANG RESIDENCE 15 Roosevelt Ave., Marblehead
ney	ď		nt Plans	SIDENC
	7			Eblehead

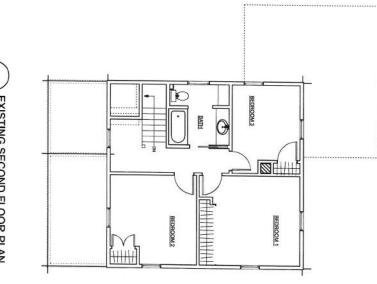

EXISTING SECOND FLOOR PLAN
Scale: 1/8" = 1'-0"

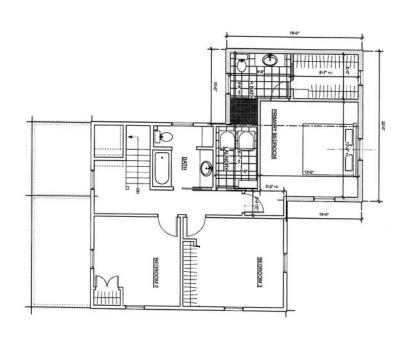


2 PROPOSED SECOND FLOOR
Scale: 1/8" = 1'-0"

23 California Road Reading, MA 01867 (781) 942-0146			DESIGN	TWOMEY
© 2022 Nancy J. Twomey	Sheet No.	Date:	Sheet Title: Second Floor Plans	15 Roo
icy J. Two	ယ	2.13.22	Second	LANG RESIDENCE 15 Roosevelt Ave., Marblehead
86/	으		Floor Pl	e, Ma
	7		ars	CE

EXISTING FRONT ELEVATION
Scale: 1/8" = 1-0"

BASEMENT




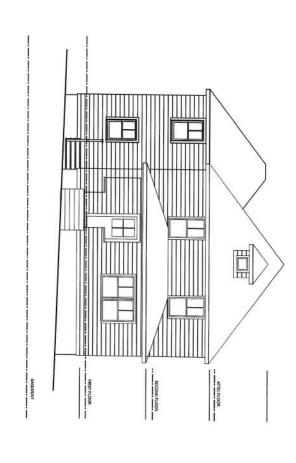

SECOND FLOOR

ATTICFLOOR

23 California Road Reading, MA 01867 (781) 942-0146			DESIGN	TWOMEY
© 2022 Nancy J. Tworrey	Sheet No.	Date:	Sheet Title: Front Elevations	15 Roo
cy J. Tw	4	2.13.22	Front B	ANG R
year	ď		levations	LANG RESIDENCE 15 Roosevelt Ave., Marblehear
	7			blehead

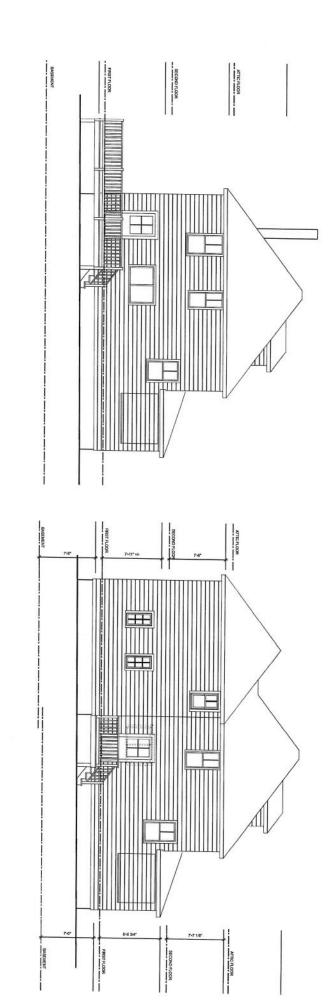

Scale: 1/8" = 1'-0"

PROPOSED SIDE ELEVATION
Scale: 1/8" = 1'-0"

23 California Road Reading, MA 01867 (781) 942-0146

Sheet No. 5 of © 2022 Nancy J. Tworrey

TWOMEY DESIGN

Sheet Title: Side Elevations

Date: 2.13.22


LANG RESIDENCE 15 Roosevelt Ave., Marblehead



© 2022 Nancy J. Twomey



R EXISTING REAR ELEVATION
Scale: 1/8" = 1'-0"

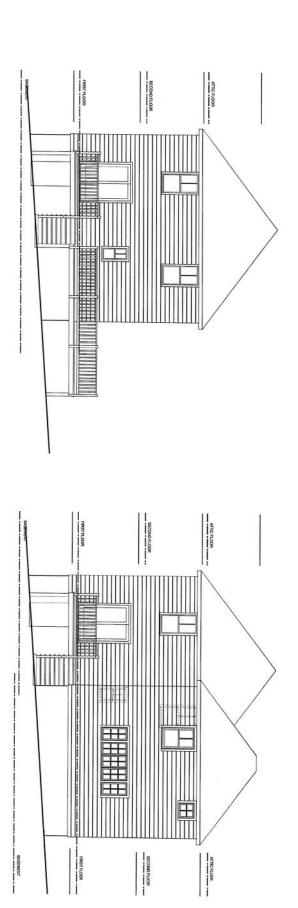

23 California Road Reading, MA 01867 (781) 942-0146			DESIGN	TWOMEY
© 2022 Nancy J. Twoney	Sheet No. 7	Date:	Sheet Title: Driveway Side Elevations	15 Roo
cy J. Two	7	2.13.22	Driveway	LANG RESIDENCE 15 Roosevelt Ave., Marblehead
16/	۹,		Side B	SIDENC 8, Mar
	7		evations	blehead

PROPOED DRIVEWAY SIDE ELEVATION
Scale: 1/8" = 1'-0"

DR EXISTING DRIVEWAY SIDE ELEVATION
Scale: 1/8" = 1'-0"

